


THORNWALL V. 241 P. 501

KIRKPATRICK V. 260 P. 524

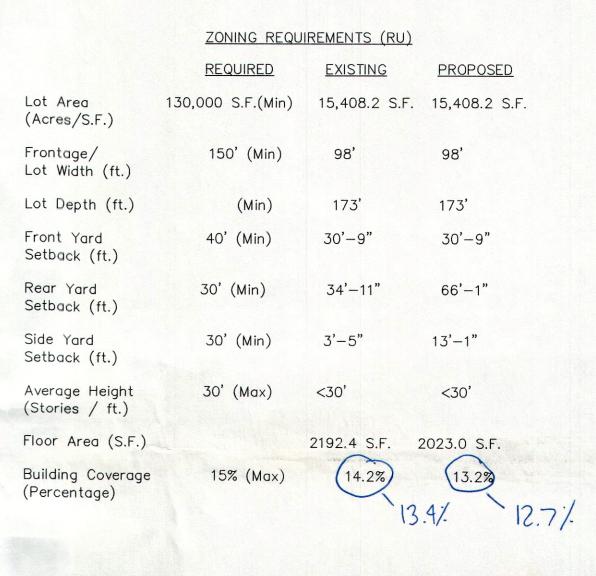

SEDIMENTATION AND EROSION CONTROL NOTES LAND DISTURBANCES SHALL BE KEPT AT A MINIMUM AND RESTABILIZATION SCHEDULED AS SOON AS PRACTICAL. ALL EROSION AND SEDIMENT CONTROL MEASURES SHALL BE CONSTRUCTED IN ACCORDANCE WITH THE LATEST
STANDARDS AND SPECIFICATIONS SET FORTH THE CONNECTICUT GUIDELINES
FOR SOIL EROSION AND SEDIMENT CONTROL BY THE CONNECTICUT COUNCIL ON SOIL AND WATER CONSERVATION. 2. ALL EROSION CONTROL MEASURES SHALL BE PROPERLY MAINTAINED IN AN EFFECTIVE CONDITION THROUGHOUT THE CONSTRUCTION PERIOD AND UNTIL PERMANENT VEGETATION COVER HAS BEEN ESTABLISHED. 3. SILT FENCE OR HAY BALES SHALL BE INSTALLED IN ACCORDANCE WITH THE DETAILS AND PLANS AND STAKED INTO PLACE. PROTECTIVE MEASURES SHALL BE PLACED BEFORE THE CUTTING AND FILLING PROCEEDS. 4. ON AREAS TO BE LEFT BARE FOR UP TO 30 DAYS, TEMPORARY SEEDING SHOULD BE USED, SUCH AS STRAW MULCH, ANCHORED IN PLACE AS REQUIRED.

5. ALL DISTURBED AREAS SHALL BE LOAMED AND SEEDED AS SOON AS POSSIBLE AFTER SYSTEM CONSTRUCTION. ALL AREAS SHALL BE PROTECTED AGAINST EROSION DURING CONSTRUCTION, USING HAY BALES AS REQUIRED.



Property Improvement Plan property of Kristine L. Thomas #5 River Road Essex, Connecticut

Date: 5-27-16

Scale: 1"=20'

A) MINIMUM LENGTH OF SILT FENCE IS 15 L.F.


B) MAXIMUM POST SPACING IS 8'-0".

C) JOINTS ONLY AT SUPPORT POST WITH MINIMUM 2' OVERLAP, SECURELY SEALED.

D) SEDIMENTATION DEPOSITS SHALL BE REMOVED WHEN THEY REACH 1/2 THE HEIGHT OF THE SILT FENCE.

E) SILT FENCE SHALL NOT BE USED IN A WATER COURSE.

F) UPON ESTABLISHMENT OF GROUND COVER ON DISTURBED AREAS, AND WHEN DIRECTED BY THE TOWN ENGINEER, FENCE WILL BE REMOVED AND ANY SEDIMENTATION WILL BE THINLY SPREAD UPON EXISTING GROUND COVER.

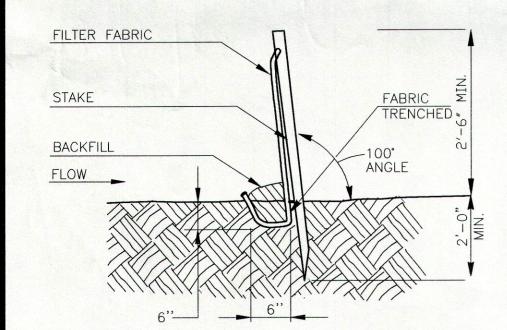


SYNTHETIC FILTER BARRIER (SILT FENCE) N.T.S.

I hereby certified that this map has been prepared pursuant to the regulations of Connecticut state agencies sections 20-300b-1 through 20-300b-20 and the "Standards for Surveys and Maps in the state of Connecticut" as adopted by the Connecticut Association Of Land Surveyor's, Inc. on September 26, 1996;

The type of survey performed is a boundary and topographic survey and is intended to show existing conditions.

Boundary determination/opinion is a first survey and is based upon locating physical evidence, map references and deed descriptions; and this survey conforms to Class A-2/T-2 accuracy standards. To my knowledge and belief this map is substantially correct as noted hereon.

The field work was performed on 4-2016.

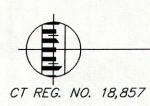

William B. Hearn, L.S. #18,857 2 Birch Circle Centerbrook, Connecticut

This map is not valid without the live signature and impression type seal of the surveyor whose signature appears hereon.

No certification is expressed or implied on any original or duplicate of this plan unless it bears the impression and/or red ink type seal and original signature of William Hearn, L.S.. These drawings are the property of William Hearn, L.S. and have been specifically prepared for the use of the owner of this project or property, they are not to be duplicated or used in part or whole for any other purpose, project, location or owner without the express written consent of William Hearn, L.S..

Bearings per map ref. Vertical datum assumed Lot area is 15,408.2 Sq. Feet Septic information shown per town records. For specific build information see architectural plans.


MAP REFERENCE

old hand dug well to be abandoned

"Boundary and Topographic Survey, Property of Kristen L. Thomas, #5 River Road, Essex, Connecticut, scale 1"=20', 4-29-16, Hearn "Property survey prepared for H. Scott Kirkpatrick and Leslie G. Kirkpatrick Essex, Connecticut" eth#475, scale 1"=40', 2-3-98, Hendriks. "Property survey map showing the division of the tract two of property of H. Scott Kirkpatrick and Leslie G. Kirkpatrick Essex, Connecticut" eth#565, scale 1"=40', 3-21-2002, Hendriks. LEGEND silt fence adjoiners' line edge of pavement setback line tree 🖰 utility pole 🗘

boundary/property line Proposed Elevation \*50

EXISTING GARAGE TO BE REMOVED.

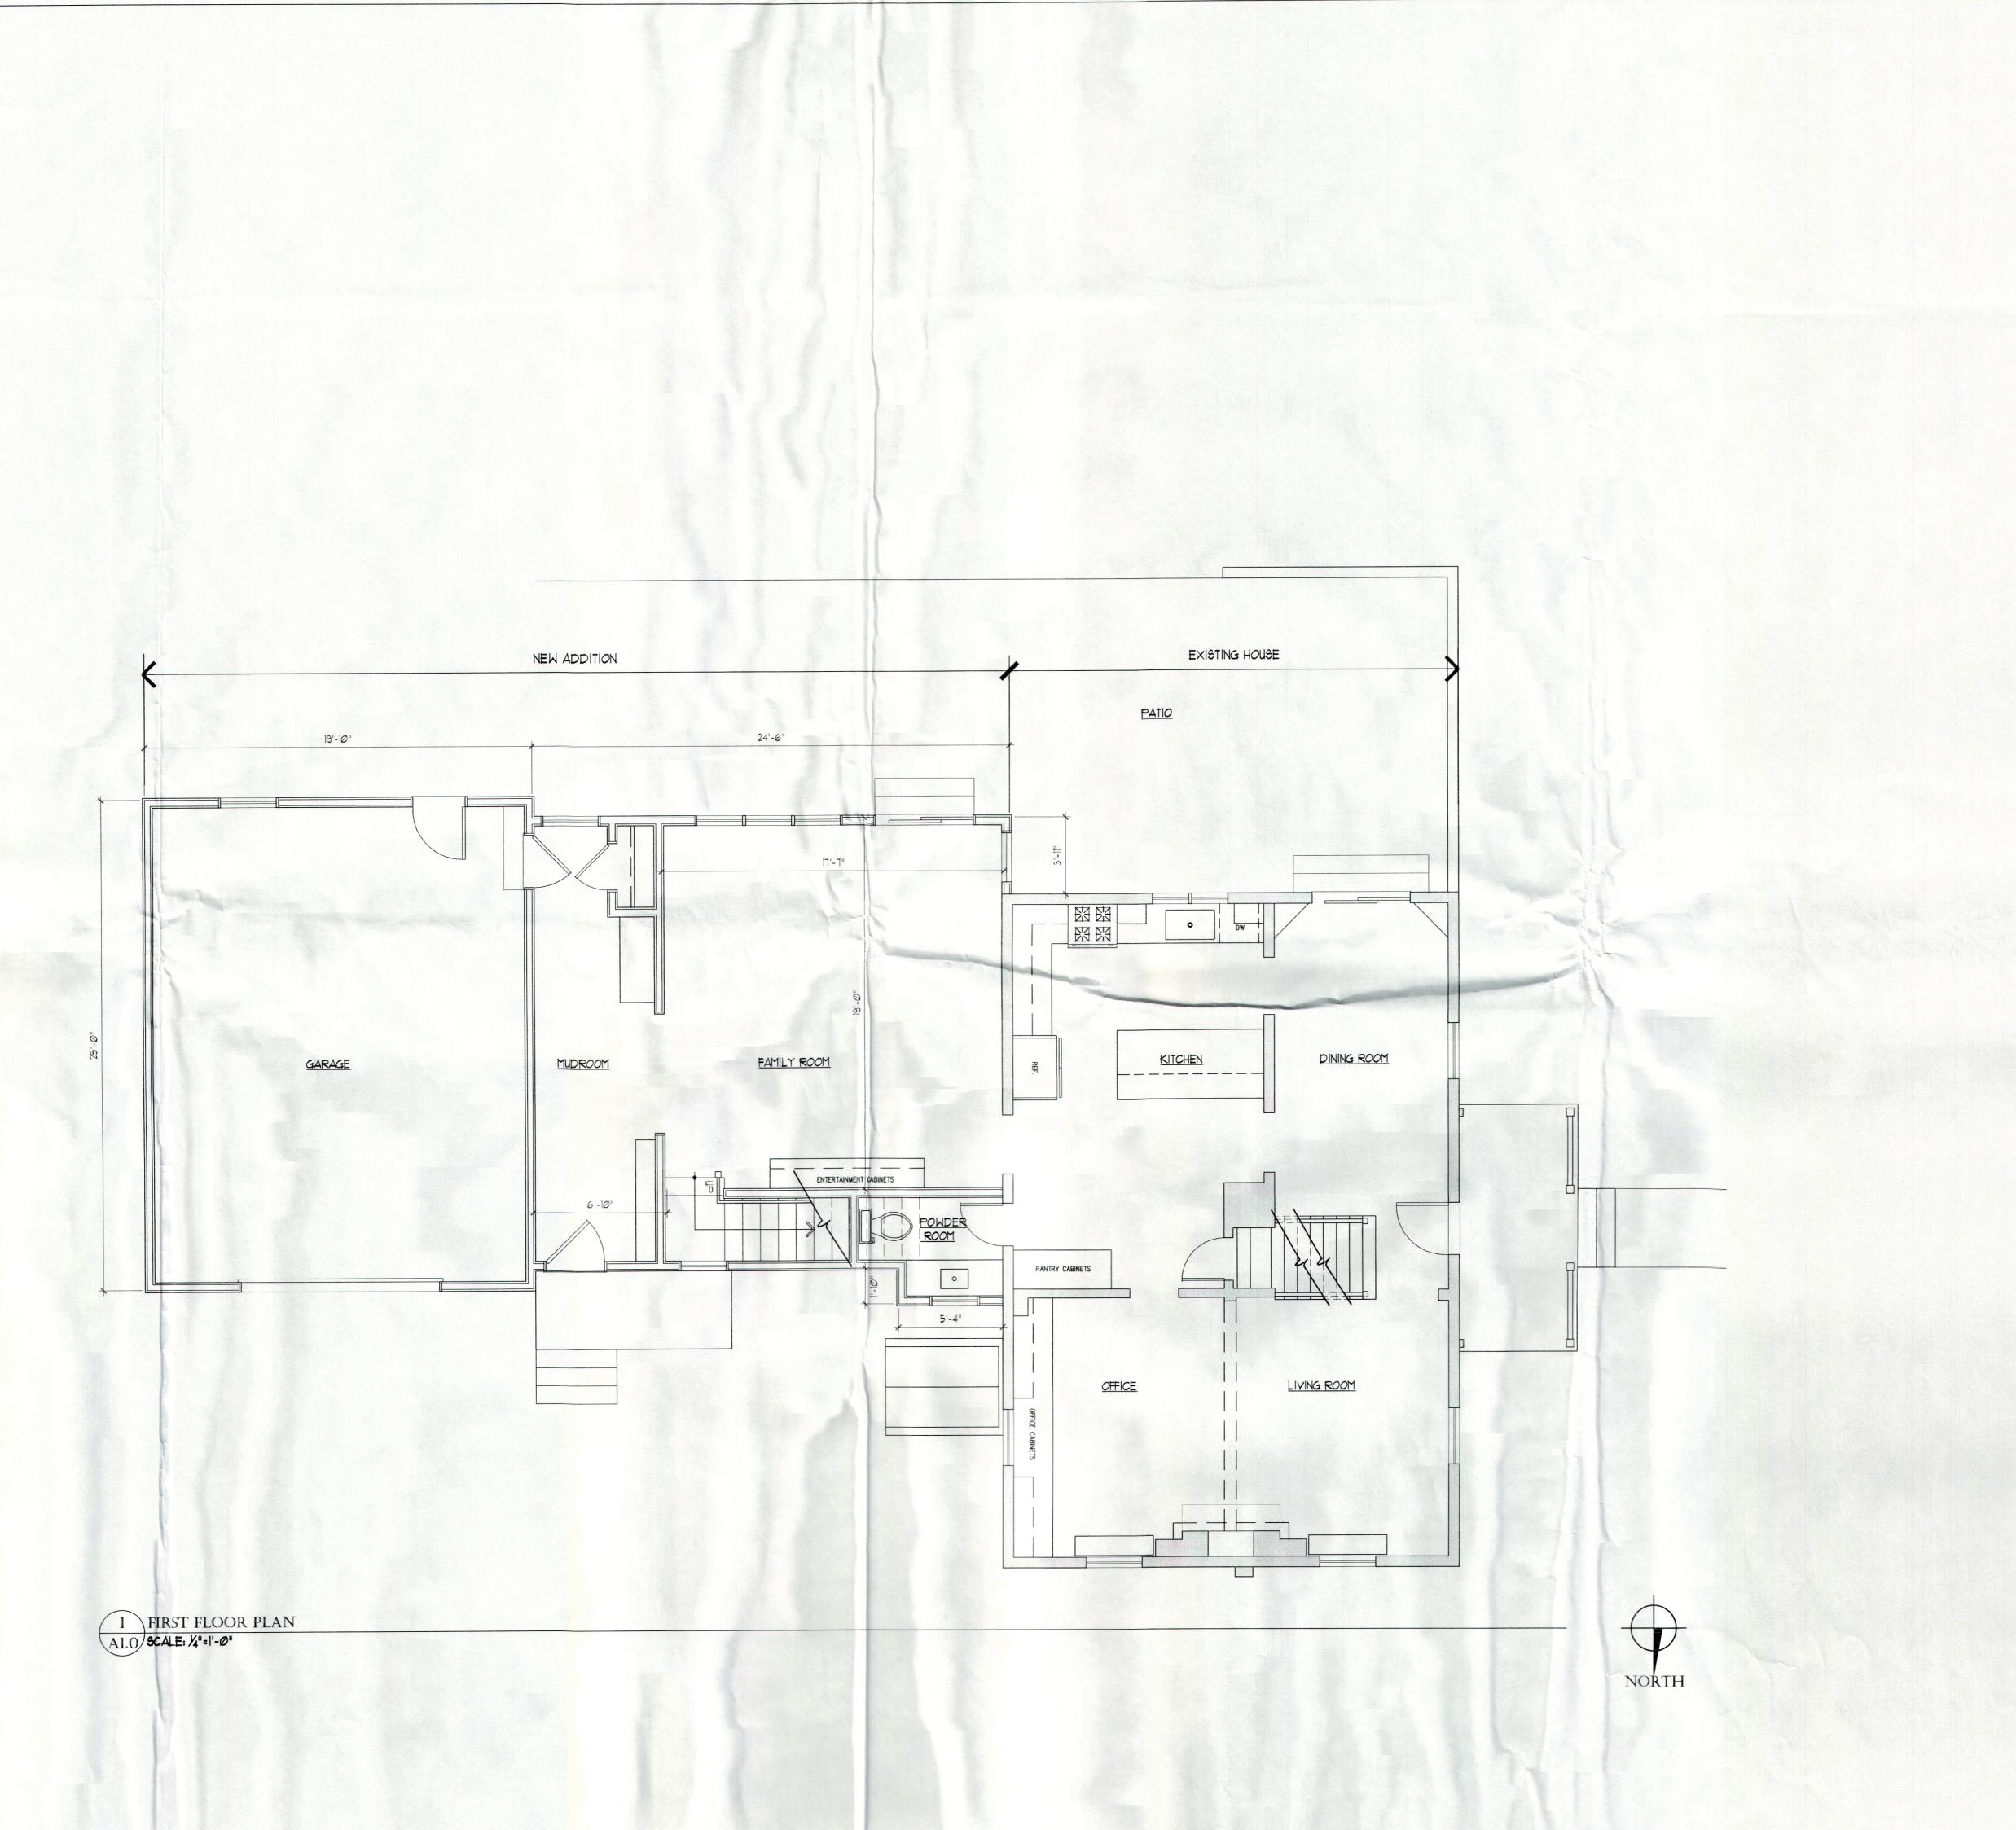

5 River Road Essex, Connecticut



35 Pratt Street Suite 105 Essex, CT 06426 tel:860.767.0767

ISSUE / REVISIONS

NO. DATE REVISIONS

I Ø527.16 ZBA Application

DRAWING NAME


FIRST FLOOR PLAN

FILE DATE

#5.27.16

DRAWING NUMBER

A1.0

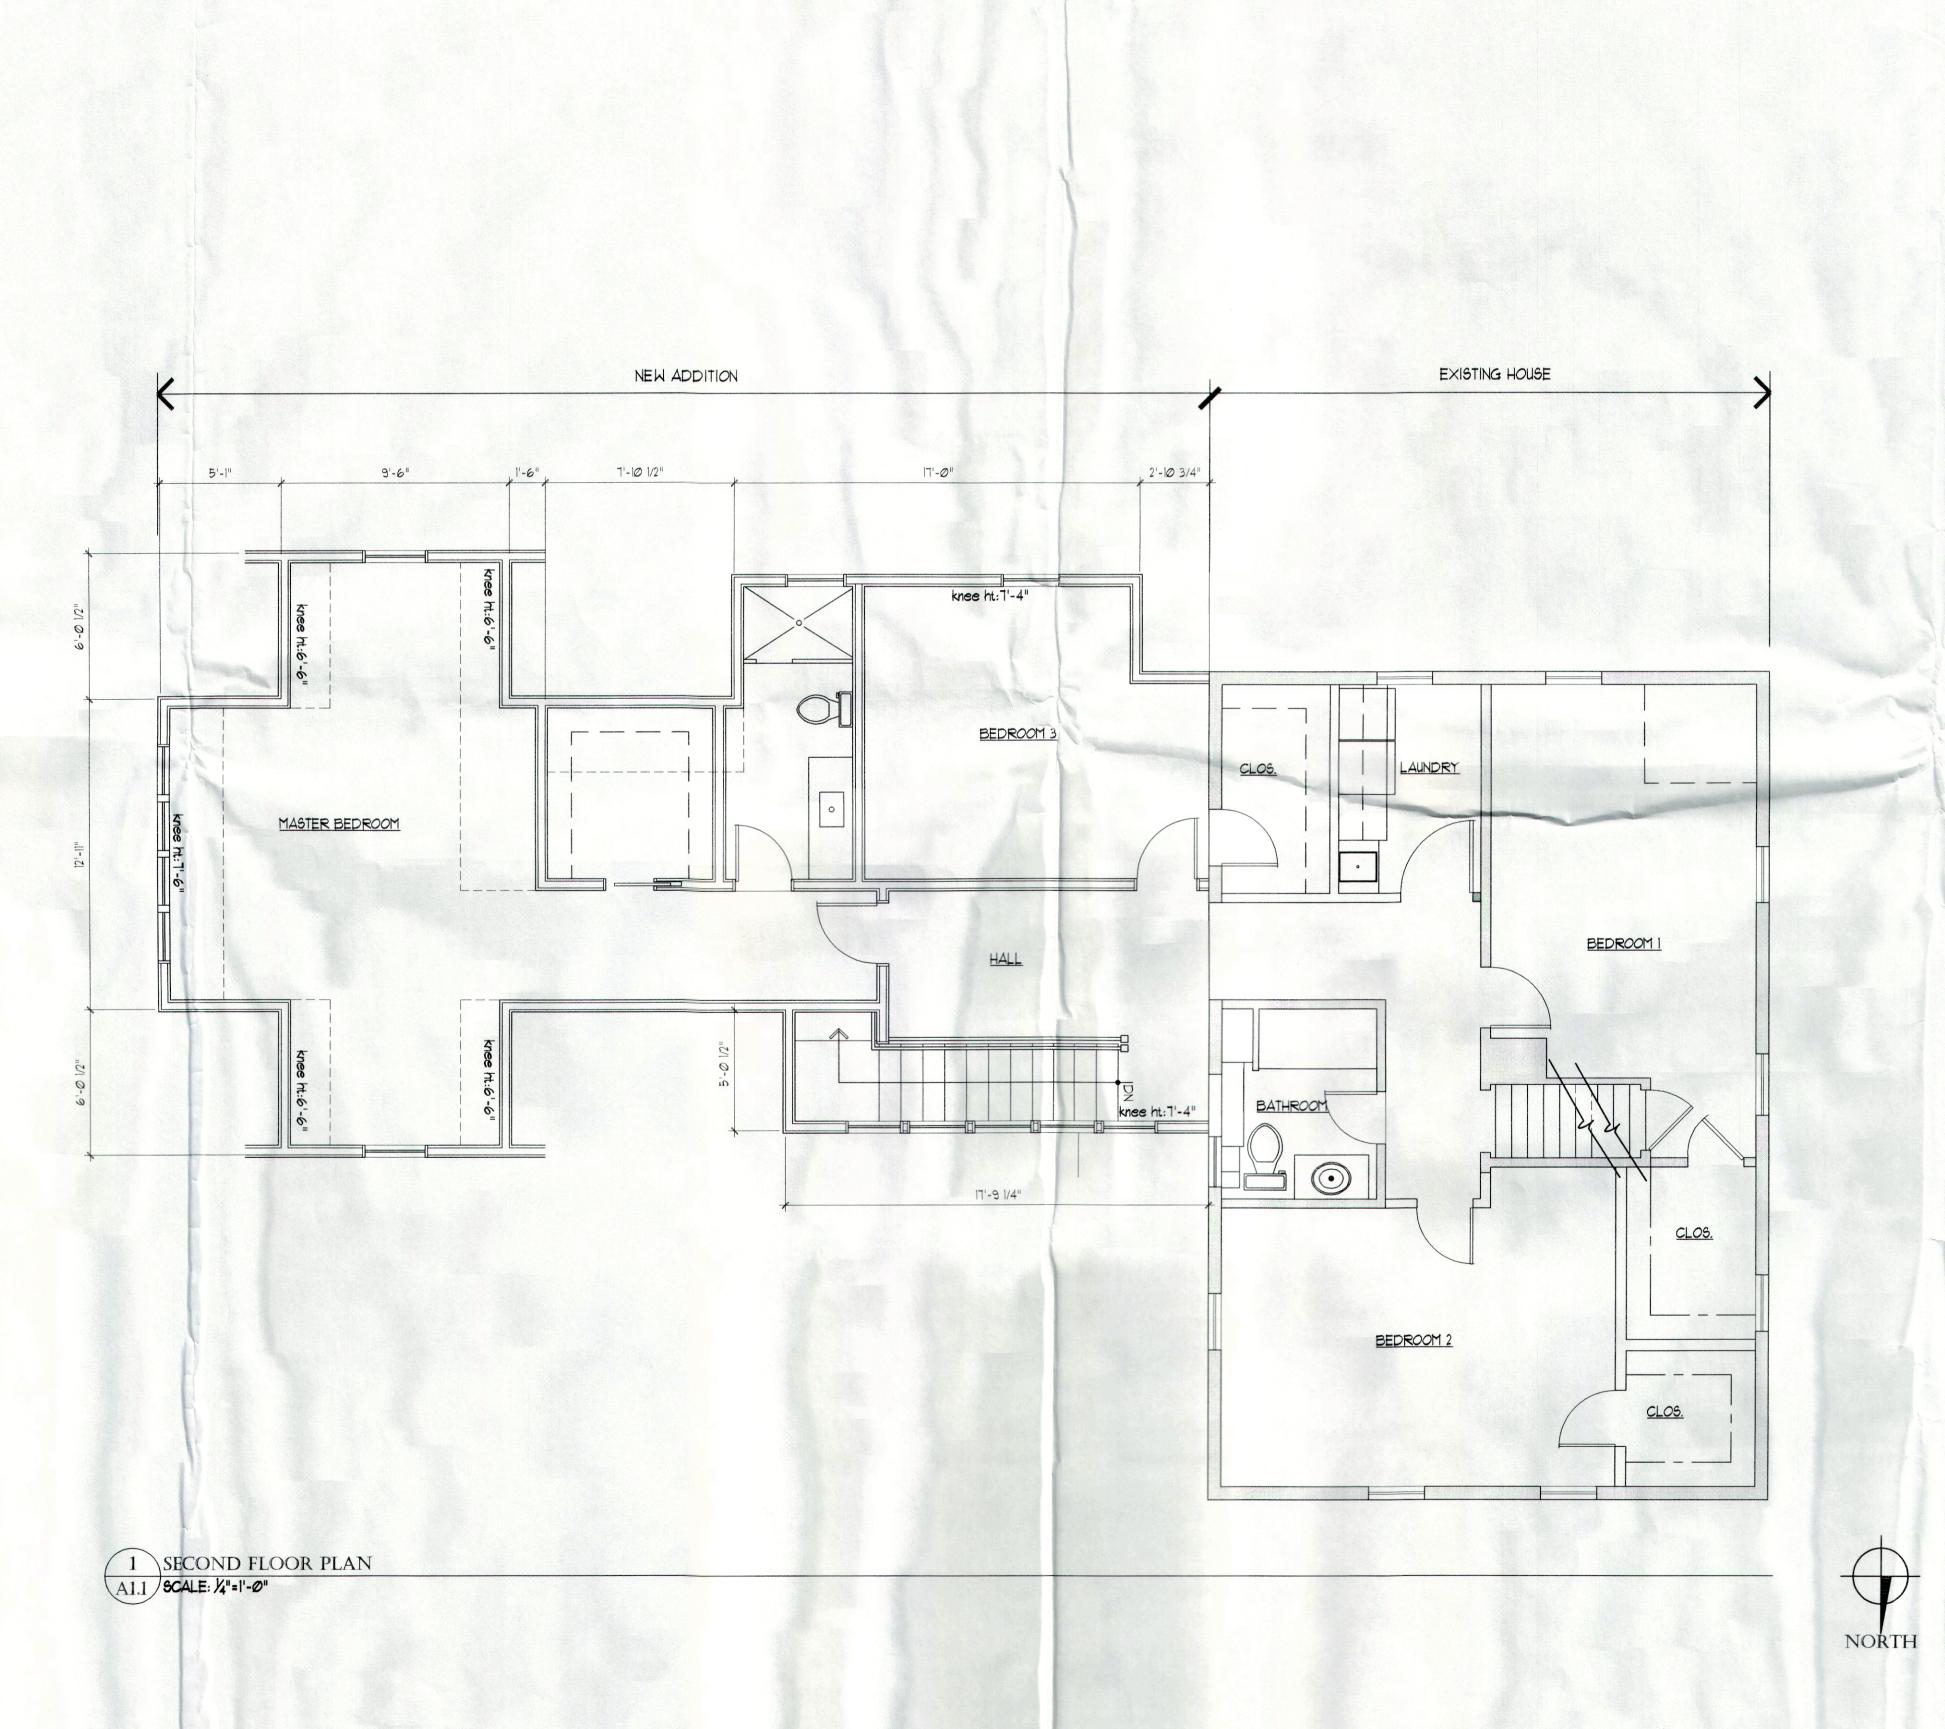

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DRAWING NAME SECOND FLOOR PLAN

DRAWN BY 05.27.16

DRAWING NUMBER



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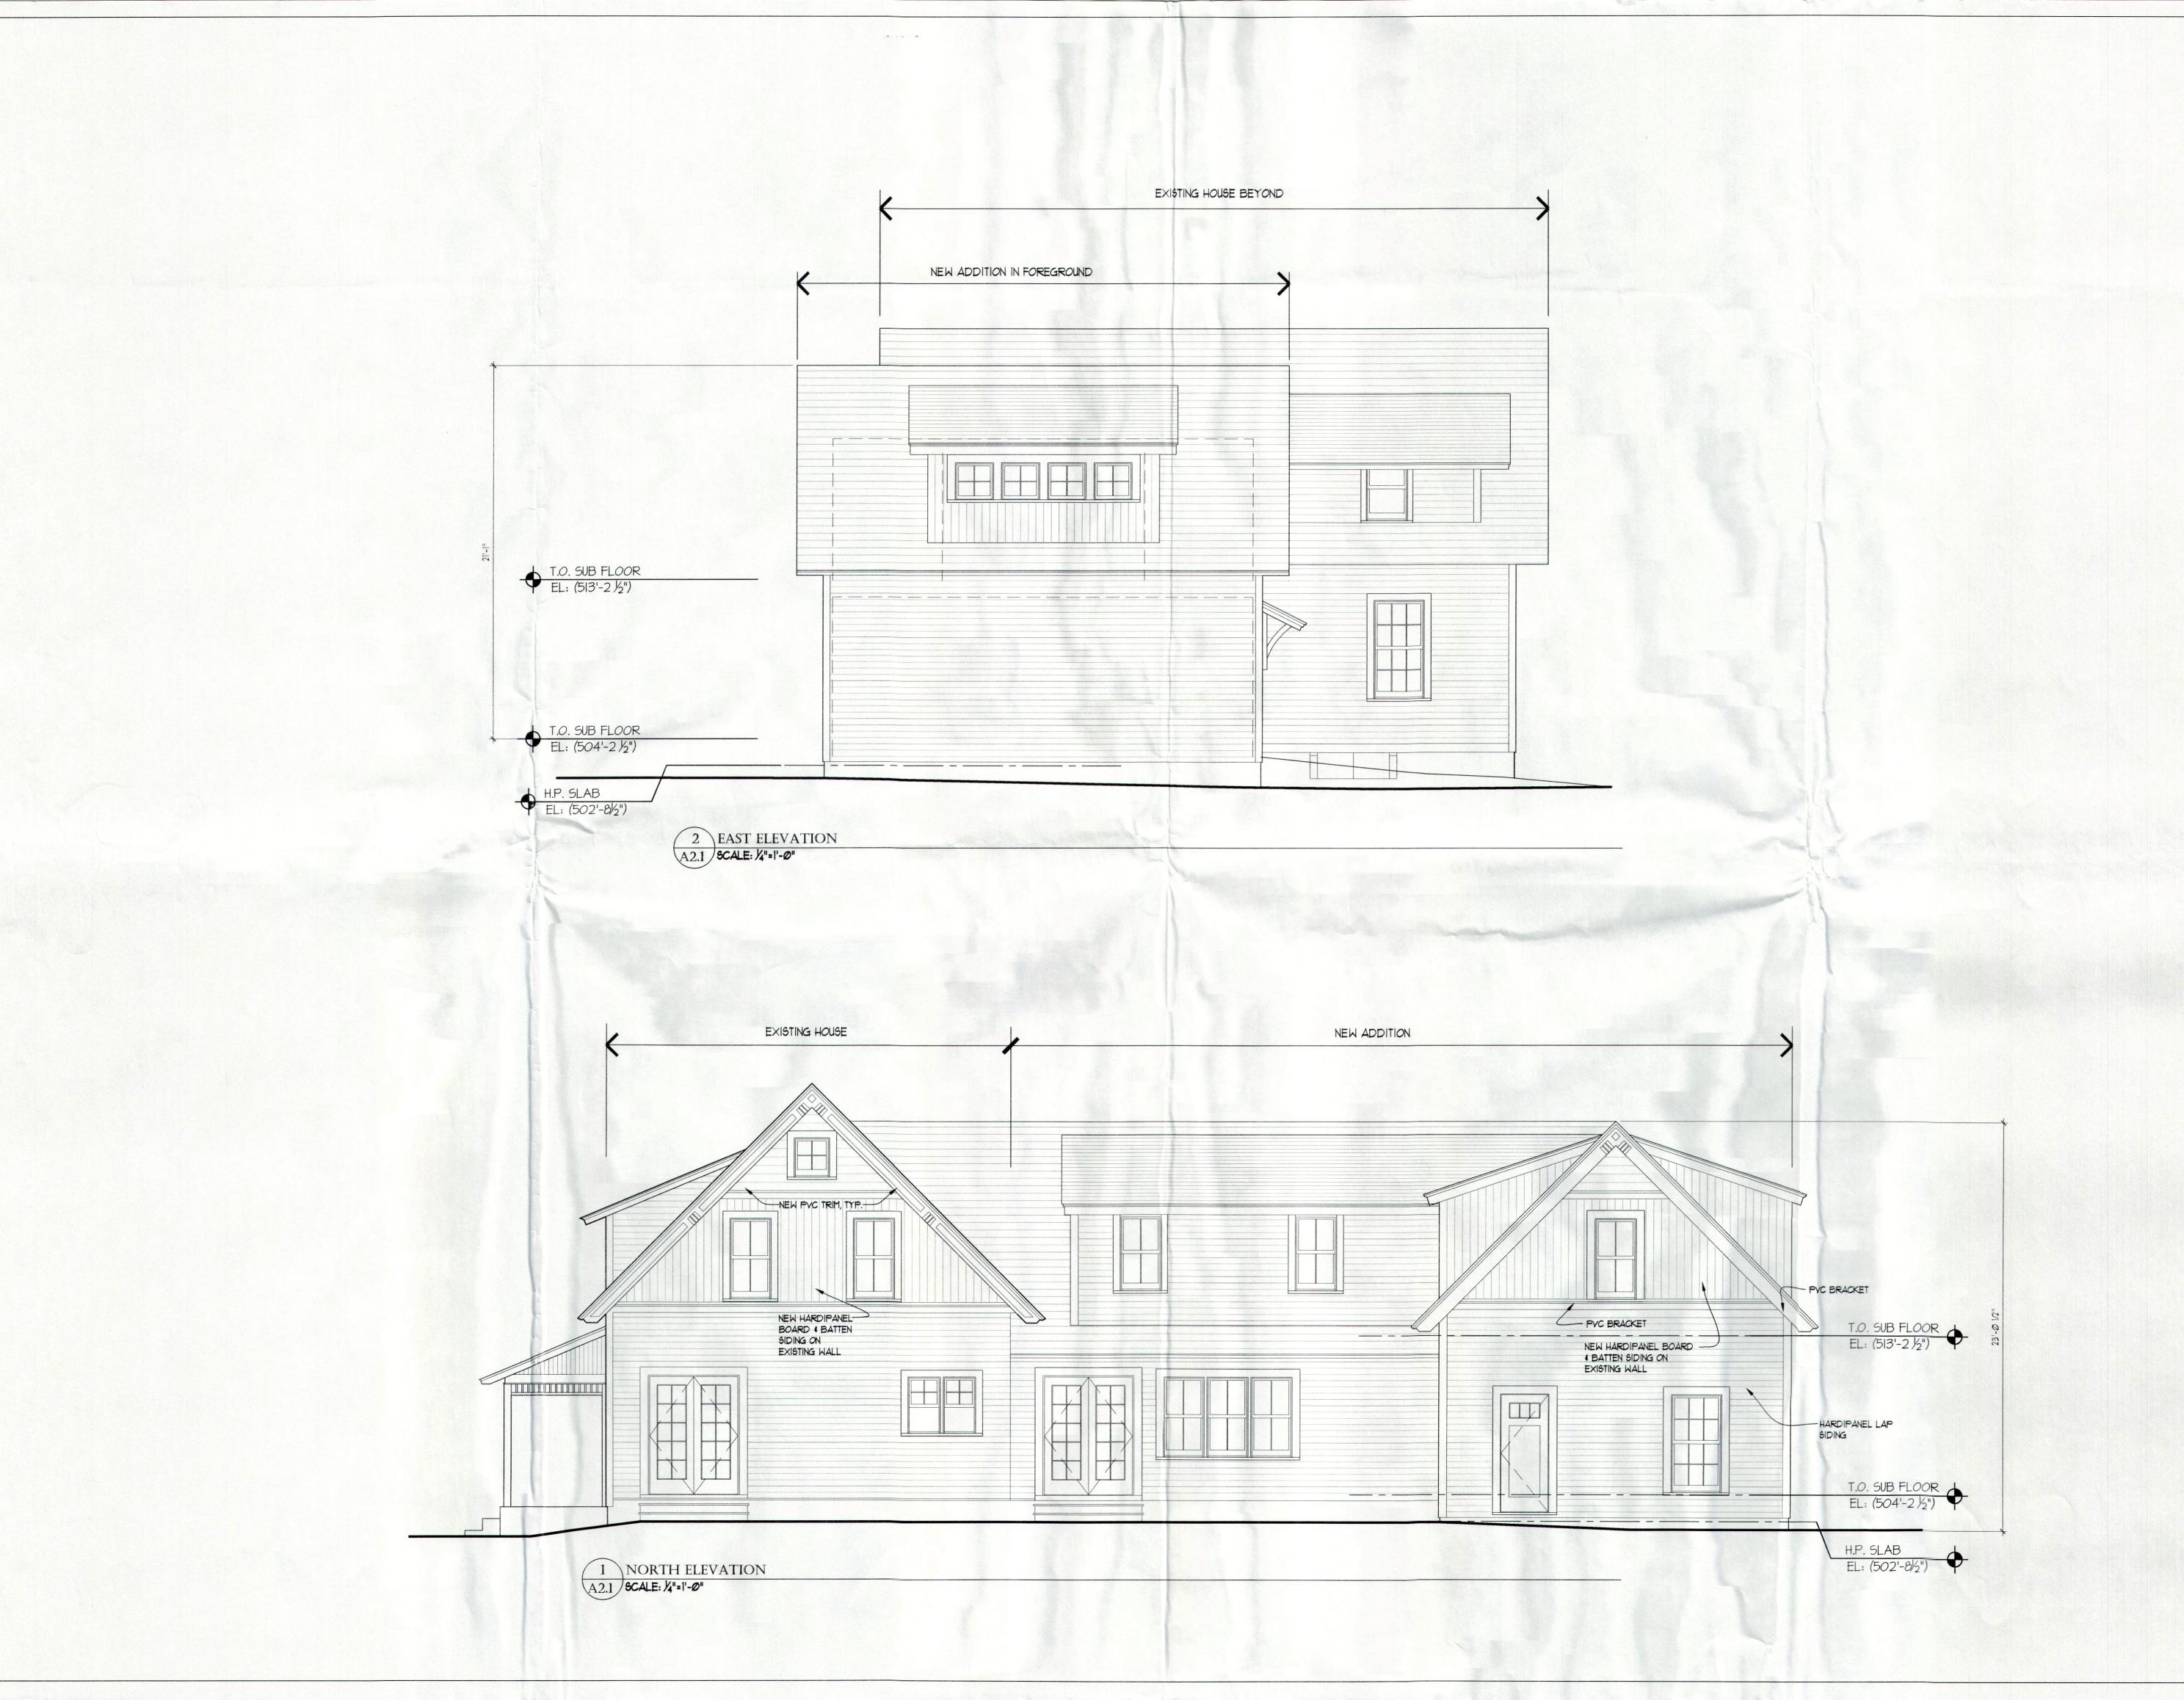
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EXTERIOR
ELEVATIONS

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HCP
FILE DATE
0527.16

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A2.0



5 River Road Essex, Connecticut



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I 0527.16 ZBA Application

DRAWING NAME

EXTERIOR ELEVATIONS

HCP
DATE
0527.16

DRAWING NUMBER

A2.1