

Connecticut Department of Energy & Environmental Protection Bureau of Water Protection & Land Reuse Land & Water Resources Division

LWRD License Application Pre-Submission Consultation Form

Harbor Management Commission

You need to complete and submit this form only if your town has a Harbor Management Commission.

To the applicant- Prior to the submission of your license application to the Connecticut Department of Energy and Environmental Protection (DEEP) Land & Water Resources Division (LWRD), please complete Part I, below, and submit this form to your local harbor management commission (contact the town for the appropriate contact person) with a location map of your site and project plans. Once the commission returns the completed form to you, please submit it along with your license application to DEEP.

Part I: To be completed by APPLICANT

1.	Applicant/Registrant Information					
	Name: <u>Edward Bombaci</u>					
	Mailing Address: <u>PO Box 220</u>					
	City/Town: <u>Hadlyme</u>	State: <u>CT</u>	Zip Code: <u>06439</u>			
	Business Phone:	Ext.:				
	Contact Person: Edward Bombaci	Title: <u>Owner</u>				
	Business Phone: <u>860-575-0109</u>	Ext.:				
	E-mail: <u>bombaciconst@aol.com</u>					
2.	Engineer/Surveyor/Agent Information (list as applied	cable)				
	Name: Coastline Consulting & Development, LLC	Title: <u>Project N</u>	<u>Manager</u>			
	Mailing Address: <u>57-B East Industrial Road</u>					
	City/Town: <u>Branford</u>	State: <u>CT</u>	Zip Code: <u>06405</u>			
	Business Phone: <u>203-433-4486</u>	Ext.:				
	Contact Person: David Provencher	Title: <u>Project N</u>	<u>Manager</u>			
	Business Phone: <u>203-433-4486</u>	Ext.:				
	E-mail: <u>david@coastlineconsulting-ct.com</u>					
	Service Provided: Consulting					
3.	Site Location:					
	Name of Site : Bombaci Family, LLC					
	Street Address: Great Meadow Road					
	City/Town: <u>Essex</u>	State: <u>CT</u>	Zip Code: <u>06426</u>			
	Tax Assessor's Reference: Map <u>2</u>	Block	Lot <u>4</u>			
	Name of Waterbody: <u>Connecticut River</u>					
4.	⊠ Confirm location map and site plans are attach	ed.				
	Date of plans: <u>8/12/20</u>					
5.	Provide or attach a brief, but thorough description	ovide or attach a brief, but thorough description of the project.				
	Bombaci Family, LLC proposes to construct an elevated platform and expand an existing dock to					
	support a marine construction business and shad fishing at their Essex property on the Connecticut River. The elevated platform will measure approximately 31' x 78' (2,154 SF) with a					

deck elevation of 7.0' MLW. The dock expansion will involve replacing the existing floating dock with a 10' x 60' main floating dock and two (2) 4' x 18' floating finger docks at the end to form a Thead (all restrained by anchor piles), and installation of four (4) dolphin tie-off piles. In addition, the applicant seeks to authorize and maintain the existing boulder/cobble shoreline.

Part II: To be completed by HARBOR MANAGEMENT COMMISSION

This consultation form is required to be submitted as part of an application for a Structures, Dredging & Fill license (Connecticut General Statutes (CGS) Section 22a-361) and/or Tidal Wetlands license (CGS Section 22a-32) to DEEP LWRD. The application has not yet been submitted to DEEP. Please review the enclosed materials and determine whether the project is consistent or inconsistent with your local Harbor Management Plan. You may also provide comments or recommendations regarding the proposal. The Harbor Management Commission may still provide written comments to the Commissioner during DEEP's public notice comment period. Should you have any questions regarding this process, please call LWRD at 860-424-3019. Please return the completed form to the applicant within 60 days of receipt or consistency will be assumed.

HARBOR MANAGEMENT COMMISSION DETERMINATION:					
Check one of the following:					
The Commission has determined that the work as deso CONSISTENT with the Harbor Management Plan.	The Commission has determined that the work as described in Part I of this form and attachments is CONSISTENT with the Harbor Management Plan.				
The Commission has determined that the work as described in Part I of this form and attachments is INCONSISTENT with the following section of the Harbor Management Plan:					
COMMENTS/RECOMMENDATIONS (or check here if attached: 🔲):					
Signature of Commission Representative	Date				
Print Name of Commission Representative	Title				

WATERFRONT IMPROVEMENT PROJECT

BOMBACI FAMILY, LLC ESSEX, CONNECTICUT

	DRAWING LIST				
SHEET NO.	SHEET TITLE	ORIGINAL DATE	REVISION DATE	NOTES	
1 OF 9	TITLE SHEET	8-12-2020			
2 OF 9	USGS TOPOGRAPHIC QUADRANGLE MAP	8-12-2020			
3 OF 9	TAX ASSESSOR'S MAP	8-12-2020			
4 OF 9	EXISTING CONDITIONS INDEX MAP	8-12-2020			
5 OF 9	EXISTING CONDITIONS PLAN	8-12-2020			
6 OF 9	PROPOSED CONDITIONS PLAN	8-12-2020			
7 OF 9	CROSS-SECTIONS A & C	8-12-2020			
8 OF 9	ELEVATION D	8-12-2020			
9 OF 9	ELEVATIONS B & E	8-12-2020			


PROJECT NOTES

REFERENCE IS MADE TO THE FOLLOWING MAPS:


- A. "TOPOGRAPHIC SURVEY & HYDROGRAPHIC SURVEY, BOMBACI FAMILY LLC, GREAT MEADOW ROAD, ASSESSOR MAP 2, LOT 4, ESSEX, CONNECTICUT", CERTIFIED TO CLASS T-2 STANDARDS, DATED DECEMBER 30, 2019, SCALE: 1" = 30' AND CERTIFIED BY JAMES NAGLE, L.S., LIC. NO. 15195.
- B. "NFIP, FLOOD INSURANCE RATE MAP, MIDDLESEX, CONNECTICUT", MAP NUMBER 09007C0269G, REVISED AUGUST 28, 2008, PREPARED BY THE FEDERAL EMERGENCY MANAGEMENT AGENCY.
- 2. A SUBMERGED AQUATIC VEGETATION (SAV) SURVEY WAS PERFORMED BY RICHARD SNARSKI (PROFESSIONAL WETLAND SCIENTIST #1391) ON SEPTEMBER 20, 2019. MR. SNARSKI NOTED THAT THERE IS NO SAV WITHIN 100 FEET OF THE DOCK AND BULKHEAD.
- 3. BENCHMARK, TIDE LINES, UPLAND ELEVATIONS, AND SOUNDINGS ARE REFERENCED TO MEAN LOW WATER DATUM. A CONVERSION FACTOR OF +1.6' WAS USED TO CONVERT THE DATA FROM NAVD88 TO MLW DATUM. THE CJL (COASTAL JURISDICTION LINE) ELEVATION OF 4.4' MLW DATUM IS THE VALUE FOR ESSEX, CT AS ESTABLISHED BY THE CONNECTICUT DEPARTMENT OF ENERGY & ENVIRONMENTAL PROTECTION.

GENERAL NOTES

- 2. THESE DRAWINGS WERE PREPARED FROM RECORDED RESEARCH, FIELD OBSERVATIONS, DRAWINGS NOTED HEREON, AND OTHER SOURCES.
- 3. THESE DRAWINGS ARE FOR PLANNING AND PERMITTING PURPOSES ONLY AND NOT INTENDED FOR STRUCTURAL DESIGN, BID DOCUMENTS, OR CONSTRUCTION.
- 4. THE FEMA FLOOD LINES ARE DIGITIZED FROM A REFERENCE MAP NOTED HEREON, SHOWN TO SATISFY PERMIT REQUIREMENTS, AND NOT INTENDED FOR INSURANCE OR ELEVATION CERTIFICATE PURPOSES. BASE FLOOD ELEVATIONS ARE IN NAVD88.
- 5. SITE MAY BE SUBJECT TO AND/OR TOGETHER WITH CERTAIN LITTORAL, RIPARIAN, OR OTHER RIGHTS AS PER THE RECORD MAY APPEAR. ANY UNDERGROUND AND/OR UNDERWATER UTILITY, STRUCTURE, AND FACILITY LOCATIONS DEPICTED AND/OR NOTED HEREON MAY HAVE BEEN COMPILED, IN PART, FROM RECORD MAPPING SUPPLIED BY THE RESPECTIVE UTILITY COMPANIES OR GOVERNMENTAL AGENCIES, FROM PAROLE TESTIMONY AND FROM OTHER SOURCES. THESE LOCATIONS MUST BE CONSIDERED AS APPROXIMATE IN NATURE. ADDITIONALLY, OTHER SUCH FEATURES MAY EXIST ON THE SITE, THE LOCATIONS OF WHICH ARE UNKNOWN TO COASTLINE CONSULTING & DEVELOPMENT, LLC. THE SIZE, LOCATION AND EXISTENCE OF ALL SUCH FEATURES MUST BE FIELD DETERMINED AND VERIFIED BY THE APPROPRIATE AUTHORITIES PRIOR TO ANY CONSTRUCTION. CALL BEFORE YOU DIG: 1-800-922-4455.

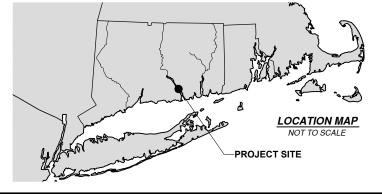


Coastline Consulting & Development 57-B East Industrial Road, Branford, CT 06405 (203) 433-4486				
<u>TITLE SHEET</u> WATERFRONT IMPROVEMENT PROJECT				
BOMBACI FAMILY, LLC GREAT MEADOW ROAD ASSESSOR MAP 2, LOT 4 ESSEX, CONNECTICUT				
8-12-2020	JOB NO. 18-110	SHEET 1 OF 9		

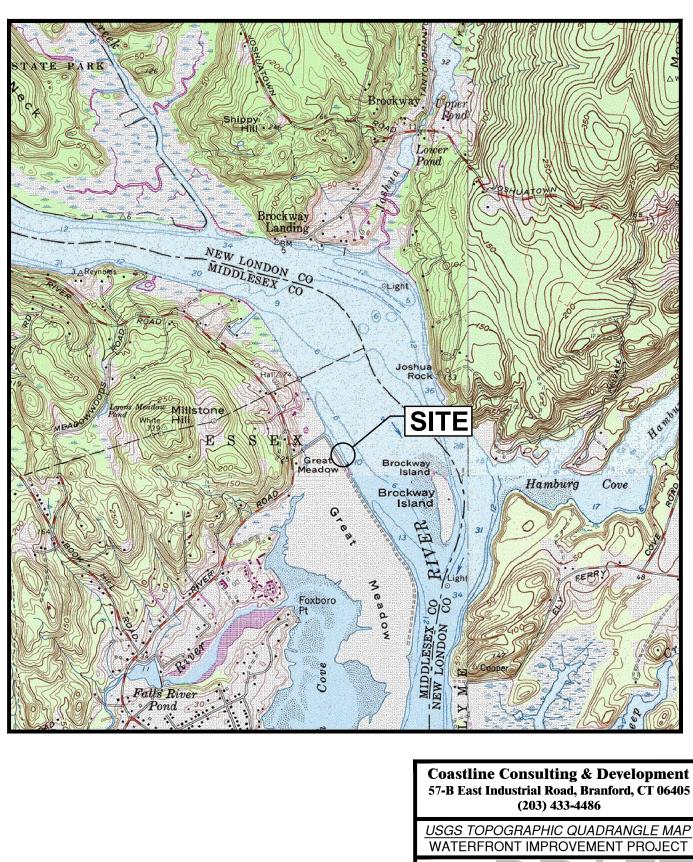



BOMBACI FAMILY, LLC GREAT MEADOW ROAD ASSESSOR MAP 2, LOT 4 ESSEX, CONNECTICUT


MAP TAKEN FROM TOPO, INC., 7.5 MINUTE USGS TOPOGRAPHIC MAPS OF THE DEEP RIVER, CONNECTICUT, QUADRANGLE, 1960 (PHOTO INSPECTED 1976, PHOTO REVISED 1984).


8-12-2020 SCALE: 1 = 24,000 SHEET 2 OF 9

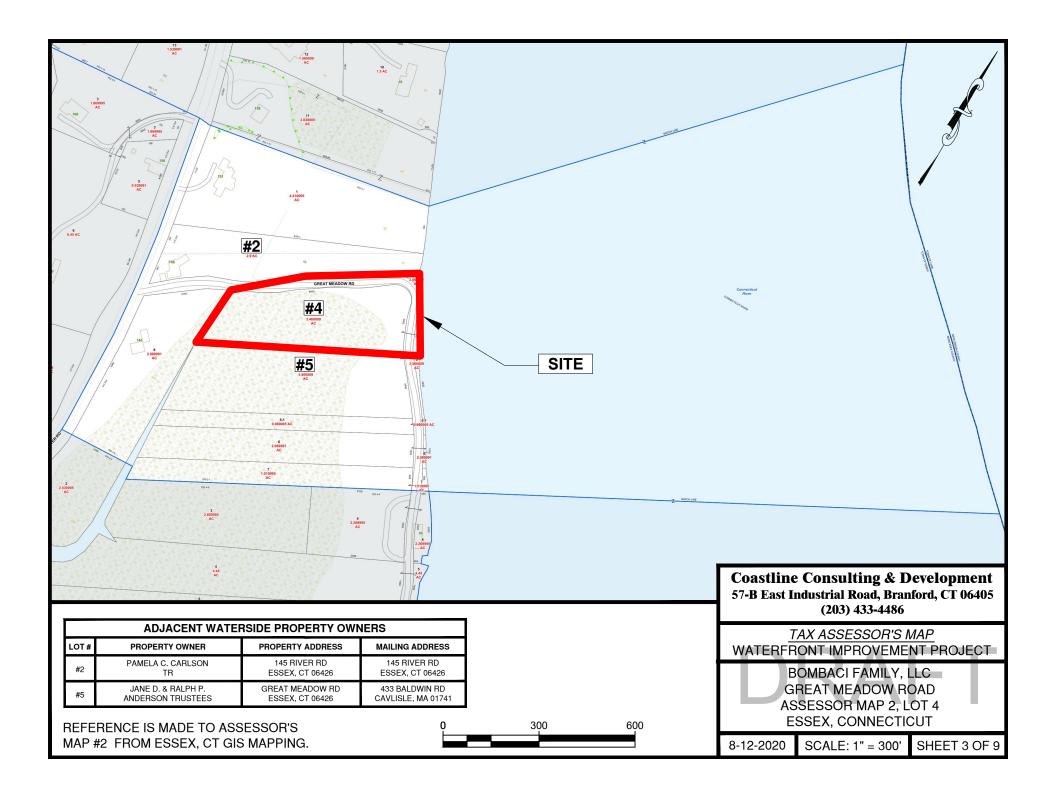


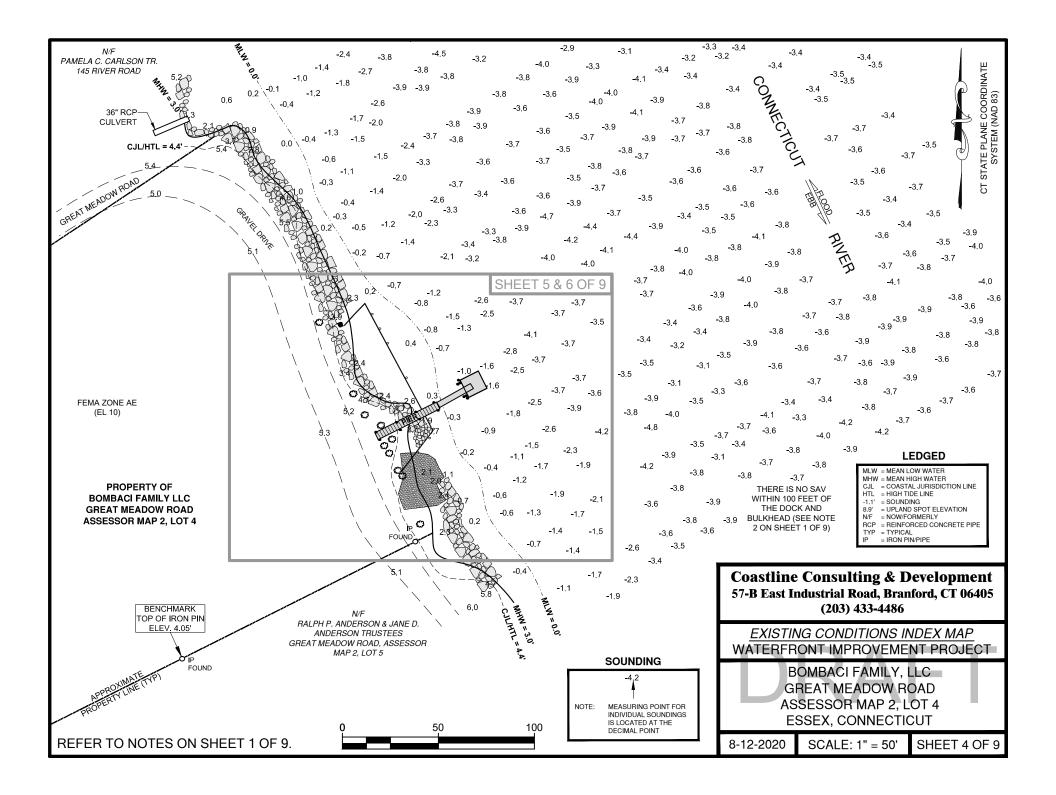


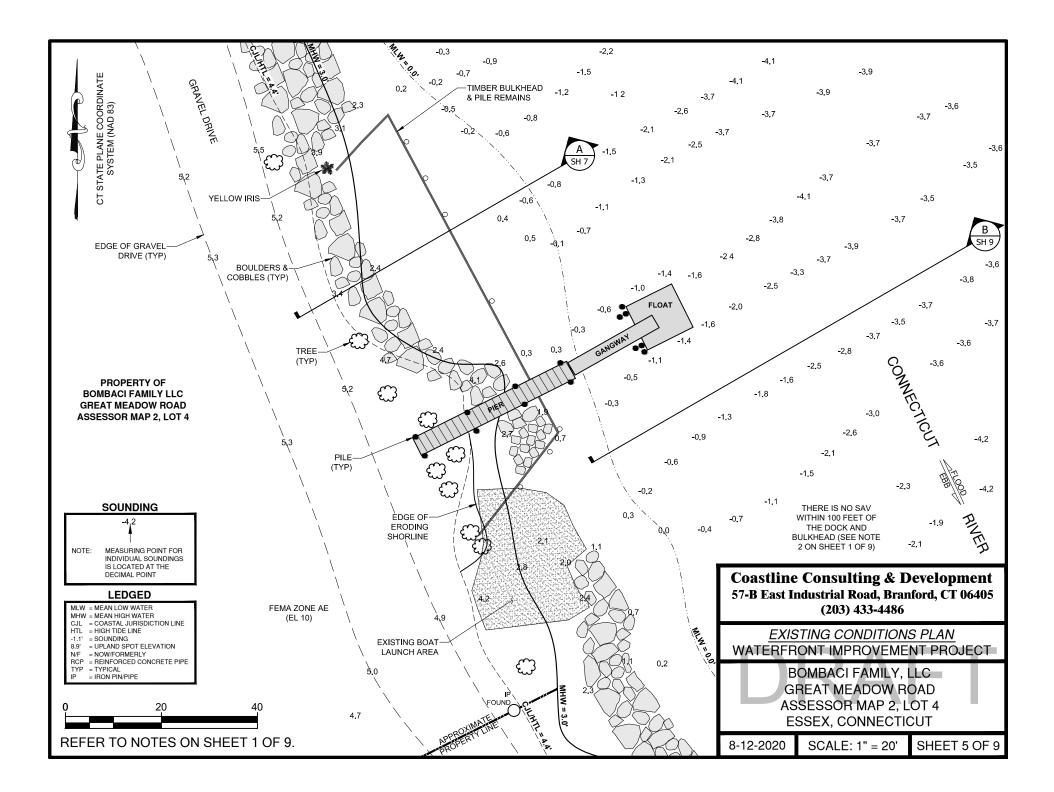

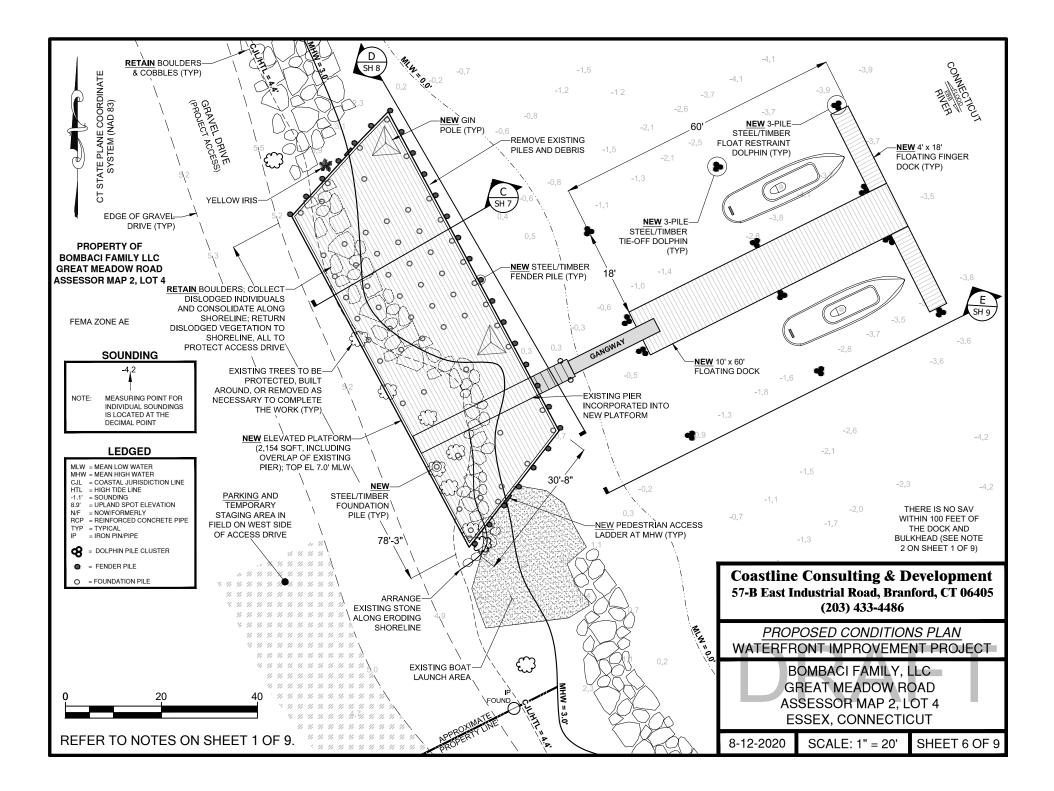

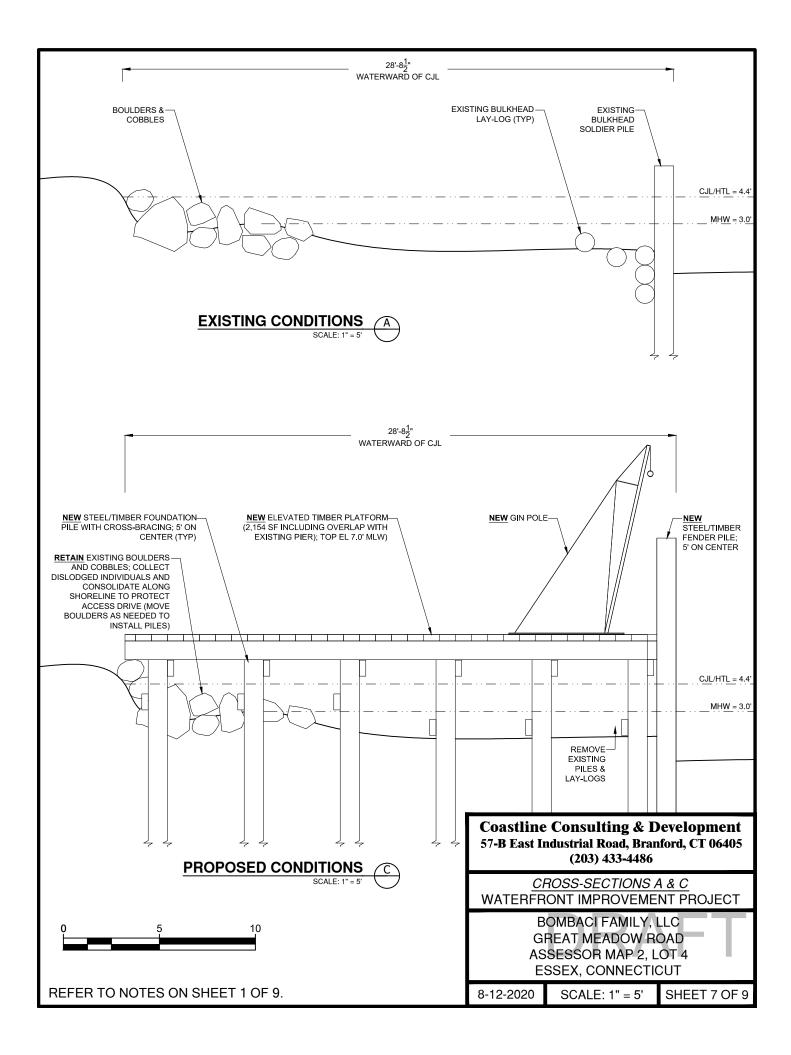

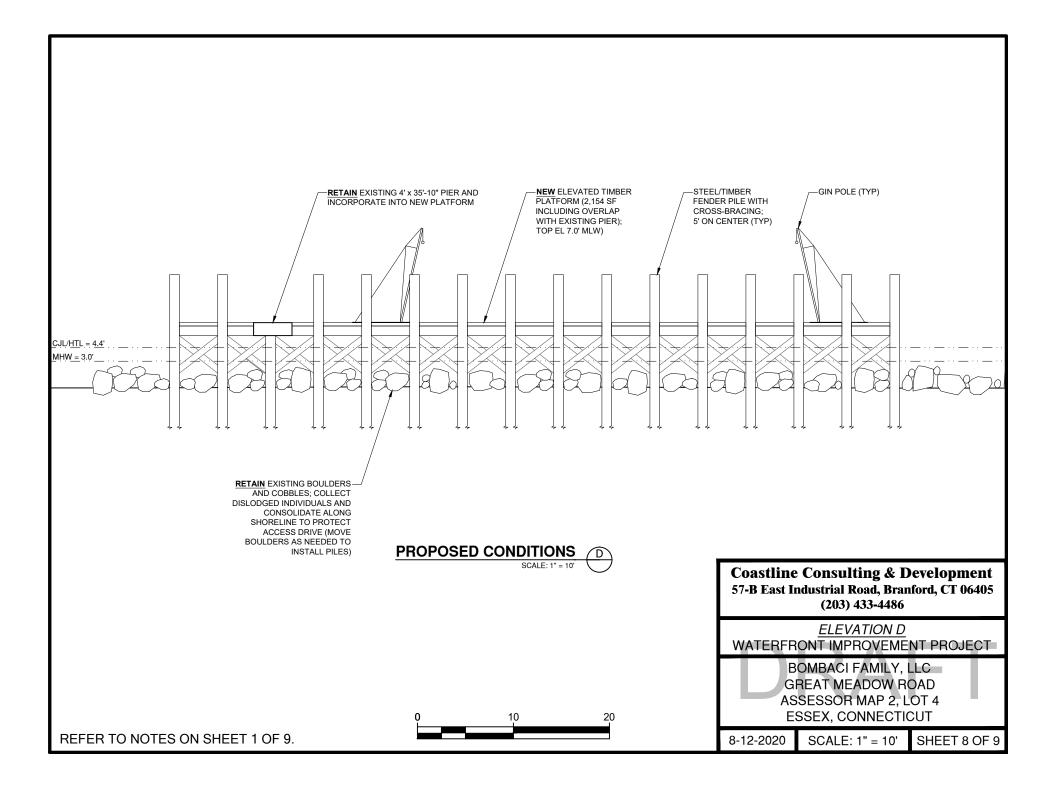

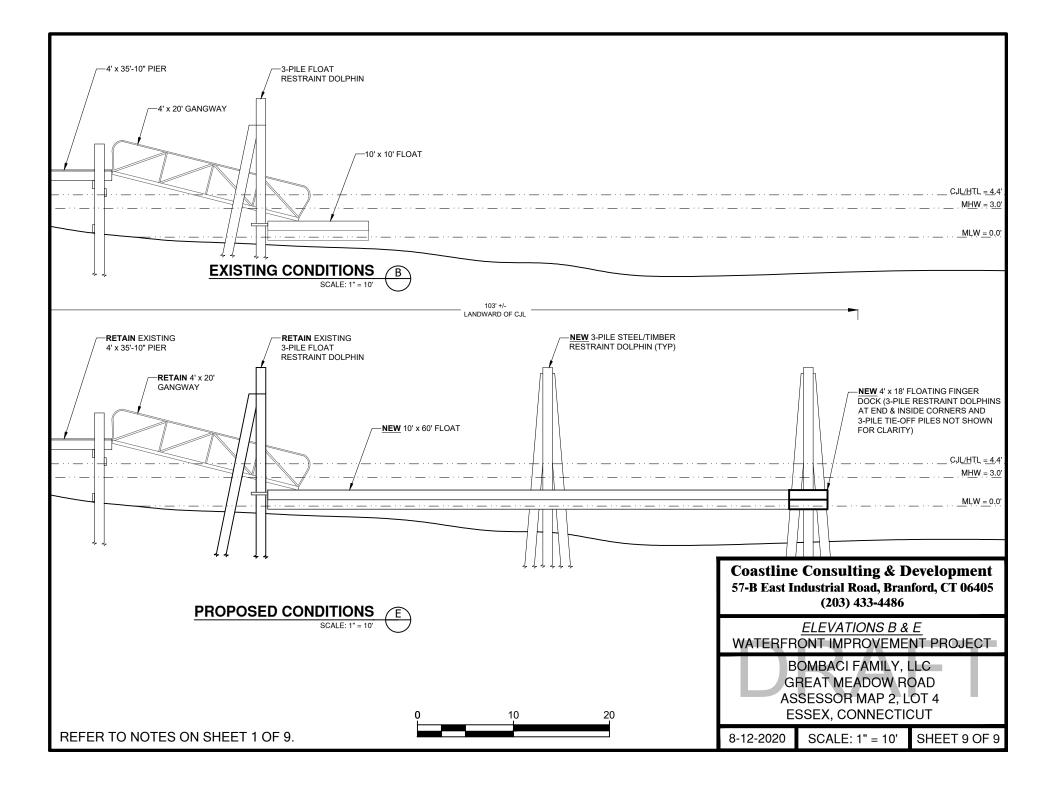



View of timber bulkhead remains and pier looking downriver.



View shoreline and timber bulkhead remains looking upriver.



View of boat launch area and dock configuration looking northeast.



View of shoreline and structures looking upriver.



View of eroding shoreline near boat launch area and access drive.



View of dislodged vegetation from eroding shoreline near boat launch area.



View of eroding shoreline and dislodged vegetation near boat launch area.



View of eroding shoreline near boat launch area and access drive.